

## CITY OF SOMERVILLE, MASSACHUSETTS MAYOR'S OFFICE OF STRATEGIC PLANNING & COMMUNITY DEVELOPMENT JOSEPH A. CURTATONE MAYOR

GEORGE J. PROAKIS EXECUTIVE DIRECTOR

PLANNING DIVISION HISTORIC PRESERVATION

## ALTERATION OF A LOCAL HISTORIC DISTRICT (LHD) PROPERTY STAFF REPORT

Site: 36 Cherry Street

**Case:** HPC.ALT 2021.45

**Applicant:** Mark Colling

Owner: Jared Floyd

**Legal Ad:** Alterations to garage structure

**HPC Meeting Date:** September 21<sup>st</sup>, 2021





The purpose of a staff report is to provide the Historic Preservation Commission (HPC) with a professional assessment of alteration proposals made for Local Historic District (LHD) properties. These assessments are based on the Historic District Ordinance (HDO) in compliance with M.G.L. Chapter 40C, and the associated Design Guidelines. A Staff Report is <u>not</u> a determination/decision and does not represent findings. A staff report does not constitute authorization in any form.



Date: September 21<sup>st</sup>, 2021 Case: HPC.ALT 2021.45 Site: 36 Cherry Street

#### I. PROJECT DESCRIPTION

<u>Subject Property</u>: The locus is the rear detached garage at 36 Cherry Street. Plate 256 of the 1934 Sanborn Map shows the garage; however, the structure was not there in the 1895 Bromley map, indicating that the date of construction was between 1895 and 1934. The main structure is a c.1890 Colonial Revival; Shingle style building known as the W.C. Mentzner House. This property is located approximately within the Spring Hill neighborhood. A full description of the property is provided in the attached Form B survey held by the Massachusetts Historical Commission (MHC).

**Proposal**: The Applicant proposes the following:

- a. Replace existing clapboard siding with shingle siding
- b. Remove and enclose louver vent opening on front and rear
- c. Install of copper 6" half round gutters and 3" downspouts
- d. Reframe front elevation eave
- e. Replace garage door

#### **II. FINDINGS**

The HPC must make findings based on the Historic District Ordinance (HDO) in compliance with M.G.L. Chapter 40C, and associated Design Guidelines. Applicable regulations are discussed below.

#### A. Replace existing clapboard siding with shingle siding

The applicable Somerville LHD Design Guidelines is A. "Exterior Walls"

Due to the change in design elements being proposed, the HPC has purview over these features and the materials used.

#### **Applicant Proposal**

The Applicant proposes removing the existing clapboard and replacing it with red cedar shingle siding to match the house.



Above: Proposed shingle siding

#### Preservation Planning Assessment:

The proposed shingle siding would match the existing shingle of the house. Additionally, the shingle siding was the historic siding for the house, and the current color and style has been approved at Staff level in the past.

Date: September 21st, 2021 Case: HPC.ALT 2021.45 Site: 36 Cherry Street

#### HPC Determination:

• The HPC must determine if, based on a review of the documentation presented, the proposed project complies with the Design Guidelines

• The HPC must structure their motion to include their own specific findings on the prosed project.

#### B. Remove and enclose louver vent opening

The applicable Somerville LHD Design Guidelines is C. "Windows and Doors"

Due to the change in design elements being proposed, the HPC has purview over these features and the materials used.

#### Applicant Proposal

The Applicant proposes removing the louver opening on the front and rear of the garage. The opening will be enclosed and covered in shingle siding.

#### Preservation Planning Assessment:

The louver vents may be original to the structure as they would have created important ventilation for the garage. The Design Guidelines state that important original and later openings should be retained where they exist. Though not a character defining feature the applicant should consider replacing the louver vent with a window. This would retain the original opening and allow the garage to be enclosed.

#### **HPC Determination:**


- The HPC must determine if, based on a review of the documentation presented, the proposed project complies with the Design Guidelines
- The HPC must structure their motion to include their own specific findings on the prosed project

#### C. Install copper 6" half round gutters and 3" downspouts

The applicable Somerville LHD Design Guidelines is B. "Roofs"

Due to the change in design elements being proposed, the HPC has purview over these features and the materials used.

#### **Applicant Proposal**

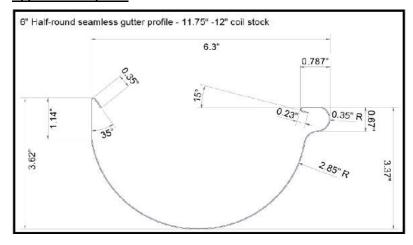

The Applicant proposes installing 6" half-round copper gutters and 3" downspouts. Currently, the structure has no gutters or downspouts.

Left: Proposed gutter profile

Date: September 21<sup>st</sup>, 2021 Case: HPC.ALT 2021.45 Site: 36 Cherry Street

#### **Preservation Planning Assessment:**

Constructed between 1895 and 1934, a structure of this period would have had wood or aluminum gutters.

Aluminum gutters that are the color of the side of the house against which they (and the downspouts) rest will be less evident and would be more appropriate than copper for the structure.

#### **HPC Determination:**

- The HPC must determine if, based on a review of the documentation presented, the proposed project complies with the Design Guidelines
- The HPC must structure their motion to include their own specific findings on the prosed project

#### D. Reframe front elevation eave


The applicable Somerville LHD Design Guidelines is **B.** "Roofs"

Due to the change in design elements being proposed, the HPC has purview over these features and the materials used.

#### **Applicant Proposal**

The Applicant proposes reframing the front elevation to change the eave and rake return detail from a flat aluminum soffit to a simplified wood sloped soffit. Such a change would include cutting the overhanging gable rafter to reduce the rake board depth.

The applicant proposes to use John Moriarty Victorian backband molding #10V33 in Spanish Cedar to be applied to a 1x6 Western Red Cedar flat casing.

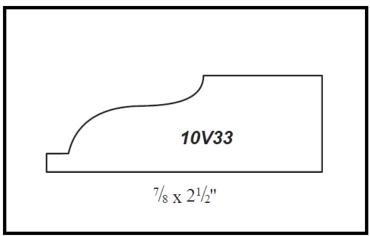

Above: Proposed backband molding

#### Preservation Planning Assessment:

These materials and design were previously approved by the HPC for use on the house.

Date: September 21<sup>st</sup>, 2021 Case: HPC.ALT 2021.45 Site: 36 Cherry Street

#### HPC Determination:

• The HPC must determine if, based on a review of the documentation presented, the proposed project complies with the Design Guidelines

• The HPC must structure their motion to include their own specific findings on the prosed project

#### E. Replacement of garage door

The applicable Somerville LHD Design Guidelines is C. "Windows and Doors"

Due to the change in design elements being proposed, the HPC has purview over these features and the materials used.

#### **Applicant Proposal**

The Applicant proposes removing the existing garage door from the front elevation and replacing it with a new Raynor, Aspen Series flush garage door. The existing garage door is a colonial recessed grooved door with three 5/1 windows. The existing garage door has an appearance similar to carriage doors. The new garage door is a flush steel door.



Above: Proposed garage door



Above: Proposed garage door details

#### **Preservation Planning Assessment:**

Given that Staff cannot determine the exact date of construction, the style of the garage doors cannot be certain. Having been constructed sometime between 1895 and 1934, the original garage door would likely have been carriage or barn doors constructed with wood.

Preservation Planning Staff recommends to the Commission that the garage door have a wood finish applied if not constructed from wood. Conditions thereto are recommended in the Conditions section.

Page 6 of 6

Date: September 21st, 2021
Case: HPC.ALT 2021.45

Site: 36 Cherry Street

#### **HPC Determination:**

• The HPC must determine if, based on a review of the documentation presented, the proposed project complies with the Design Guidelines

• The HPC must structure their motion to include their own specific findings on the prosed project

#### III. FINDINGS & VOTE

When bringing the matter to a vote the HPC must state their findings and reasons on why they takes their position.

#### IV. RECOMMENDED CONDITION

Preservation Planning recommends the following conditions be attached to any Certificate of Appropriateness that the HPC might grant for this project:

- 1. The Applicant/Owner shall file the Certificate with the Inspectional Services Department (ISD) by uploading it to the CitizenServe permitting portal with their application for zoning compliance/building permit.
- 2. This Certificate is valid for one year. If work has not commenced within one year of the HPC's date of determination, this Certificate shall expire, and the Applicant shall re-apply for re-issuance of this Certificate. Provided that no changes have been made to the proposal, this shall be a Staff-level re-issuance of the Certificate.
- 3. Any changes to this proposal made prior to the commencement of work or in-the-field changes shall be submitted to Preservation Planning for their review to determine if the changes come under the purview of the HPC.
- 4. Gutters and downspouts shall be the same color as the portion of the house against which they rest.
- 5. Gutters and downspouts shall be made from aluminum.
- 6. The garage door shall have a wood finish applied.
- 7. A written narrative or descriptive checklist identifying the completion or compliance with permit conditions must be submitted to the Inspectional Services Department with a copy to preservation Planning at least fifteen (15) business days in advance of a request for a final inspection.
- 8. The Applicant shall contact Preservation Planning at **historic@somervillema.gov** a minimum of fifteen (15) business days prior to final ISD walk-through so that Preservation Planning or their designee can confirm if the project was completed according to HPC approvals.













#### **CERTIGRADE® WESTERN CEDAR SHINGLES**

Number 1 Blue Label®





The premium grade of shingles for sidewalls and roofs. These top-grade shingles are 100% heartwood, 100% clear and 100% edge grain. Available in 16" or (18") or 24" lengths.

Number 2 Red Label





A good grade for many applications. Not less than 10" clear on 16" shingles, 11" clear on 18" shingles and 16" clear on 24" shingles. Flat grain and limited sapwood are permitted in this grade.

Number 3 Black Label





A utility grade for economy applications and secondary buildings. Not less than 6" clear on 16" and 18" shingles, 10" clear on 24" shingles.

**Number 4 Undercoursing** 





A utility grade for undercoursing of double coursed sidewalls only. Not a roofing material and not to be used as a starter course for roofs.

#### **CERTI-LABEL WESTERN CEDAR SHAKES**

Certi-Split® Handsplit Shakes





These shakes have split faces and sawn backs. Cedar logs are first cut into desired lengths. Blanks or boards of proper thickness are split and then run diagonally through a bandsaw to produce two tapered shakes from each blank. Available in Premium Grade (100% edge grain) or Number 1 Grade (Up to 20% flat grain allowed in each bundle).

Certi-Sawn<sup>®</sup> Tapersawn Shakes





These shakes are sawn both sides. Premium and Number 1 Grades are the most common. Premium Grade is 100% edge grain, 100% clear and 100% heartwood. Number 1 Grade allows up to 20% flat grain in each bundle. Number 2 and 3 Grades are also available.

Certi-Split® Tapersplit Shakes





Produced by hand, using a sharp bladed steel froe and a mallet. The natural shingle-like taper is achieved by reversing the block, end-for-end, with each split. Premium Grade only.


Certi-Split® Straight-Split Shakes





Produced by machine or in the same manner as tapersplit shakes except that by splitting from the same end of the block, the shakes acquire the same thickness throughout. Premium Grade only.

Note: Western Cedar's natural color varies.

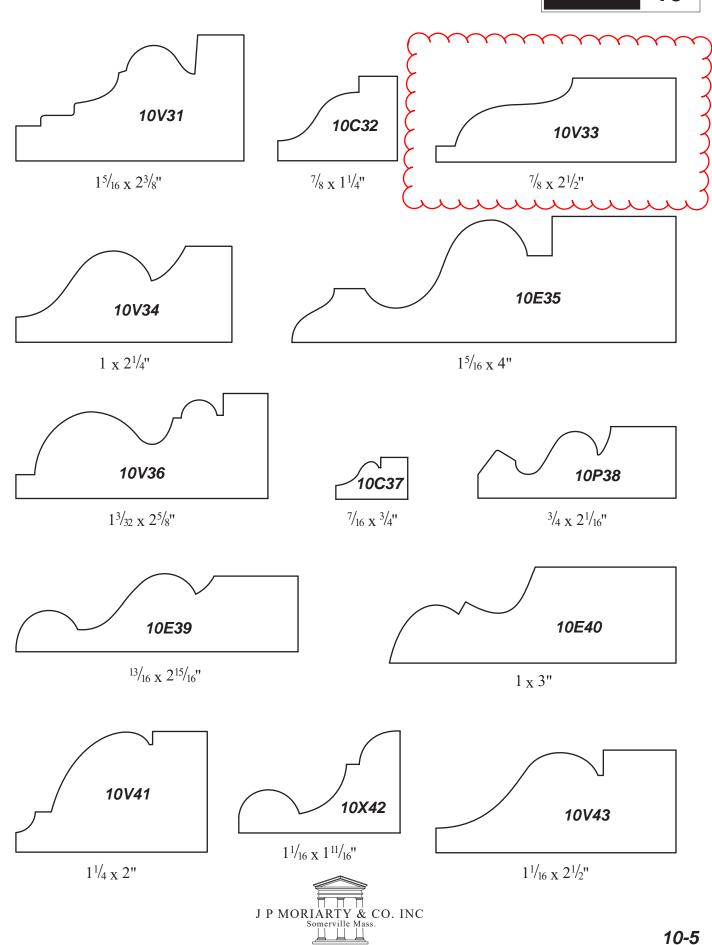



# Aspen<sup>™</sup> Series



## Design Choices, Style, Quality

When you are looking for that perfect, new door for your home, look no further than Raynor's Aspen™ Series. With all the design choices Aspen™ offers, you are sure to find the perfect combination that will enhance your home's curb appeal and value.

## **AP200 VersaView**<sup>™</sup>

With Raynor's VersaView door you have the ability to place windows in any location on your door. The VersaView offering increases the amount of light inside your garage while improving the look of your garage door that enhance the curb appeal of your home!



#### Pick your **PANEL**



#### **Recessed Ranch**


Solid Colors Available: White, Almond, Desert Tan, Sandstone, Bronze, Black, Brown Woodtones Available: Painted Auburn & Mocha



#### **Raised Ranch**

Solid Colors Available: White, Almond, Desert Tan, Sandstone, Bronze, Charcoal, Black, Brown Woodtones Available:

Distinct Finish Auburn, Driftwood & Mocha, Painted Walnut

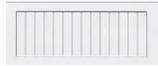

#### **Recessed Ranch Grooved**

Solid Colors Available: White, Almond, Desert Tan, Sandstone, Bronze, Charcoal, Black, Brown

Woodtones Available:

Distinct Finish Auburn, Driftwood & Mocha. Painted Walnut



#### Solid Colors Available:

White, Almond, Desert Tan, Sandstone, Bronze, Charcoal, Black, Brown

Woodtones Available:

Painted Auburn, Mocha & Walnut



#### **Raised Colonial**

Solid Colors Available: White, Almond, Desert Tan, Sandstone, Bronze, Charcoal, Black, Brown

Woodtones Available: Distinct Finish Auburn, Driftwood & Mocha, Painted Walnut



#### **Recessed Colonial Grooved**

Solid Colors Available:

White, Almond, Desert Tan, Sandstone, Bronze, Charcoal, Black, Brown Woodtones Available:

Distinct Finish Auburn, Driftwood & Mocha, Painted Walnut



#### **Mixed Panel**

Solid Colors Available: White, Almond, Desert Tan, Sandstone, Bronze, Charcoal, Black, Brown

Woodtones Available:

Distinct Finish Auburn, Driftwood & Mocha, Painted Walnut



#### **Plank**

Solid Colors Available:

White, Almond, Desert Tan, Sandstone, Bronze, Charcoal, Brown, Black

Woodtones Available:

Painted Auburn, Mocha & Walnut

#### Pick your **GLASS**

All of our windows are tightly sealed to keep the elements out of your garage. Choose from either clear, obscure or satin glass styles.




Clear




**Obscure** 



Satin

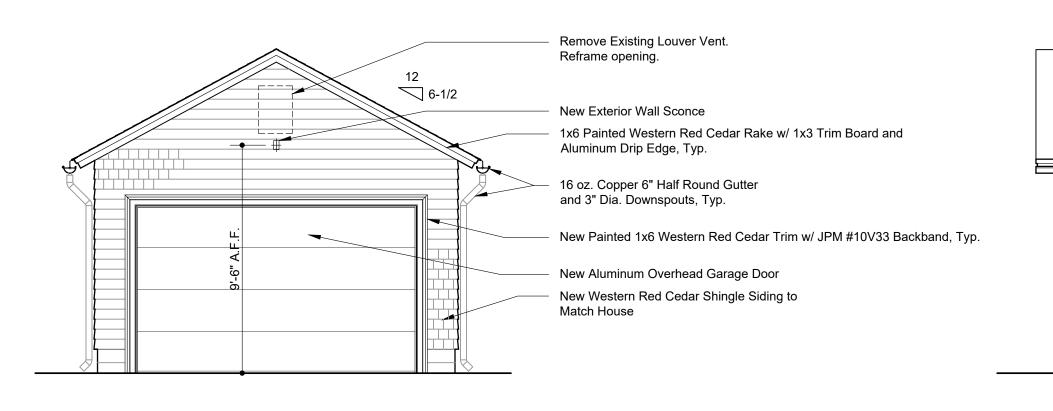

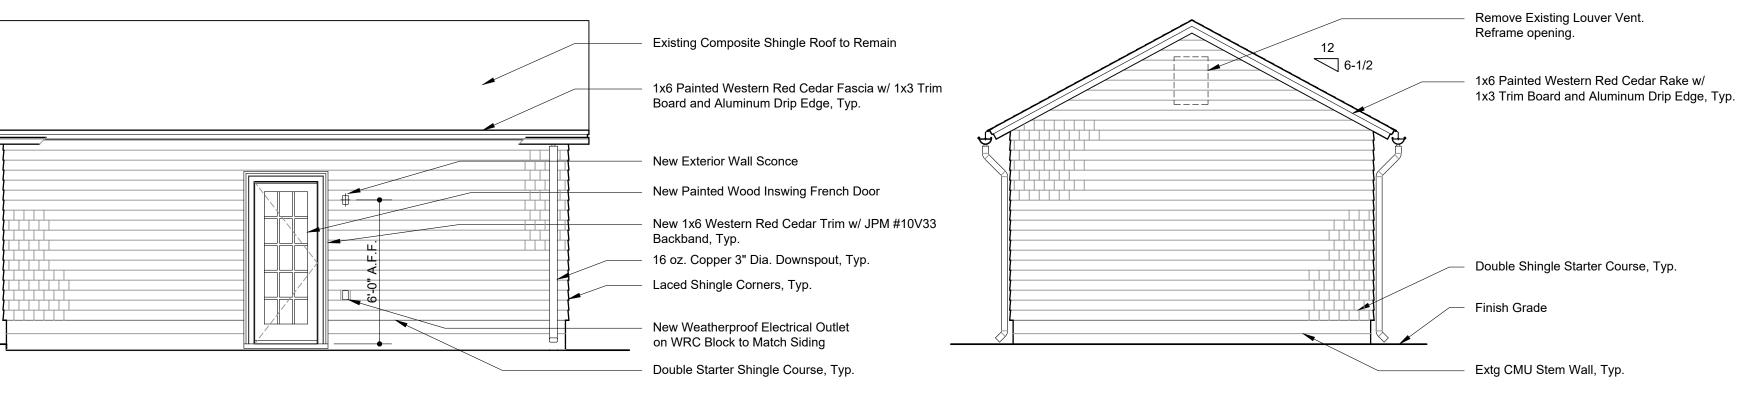

Frame Depth: See Door Types Exterior Finish: Vertical Grain Douglas Fir Interior Finish: Vertical Grain Douglas Fir Interior Glazing Profile: Ogee Hardware: Contemporary, Keyed Exterior, Satin Brass, Unlacquered Glass: Double Insulated Low-E, Argon filled Screen: Ultimate Swinging Screen with Storm Insert, Charcoal High Transparency Mesh Divided Lites: Simulated Divided Lite with Spacer Bar Casings: Painted Western Red Cedar w/ Victorian Backband to Match Main House Sill: Fiberglass bronze color sill and black weatherstrip.

Extg 2x6 WD Collar Ties

Continuous Black Plugmold, Outlets 12" o.c.,

Garage Door Opener

Garage Door Keypad

Exterior Wall Sconce w/ Motion Detector

3-gang Switches

**Door Specifications** 

Unit Code/Item Size: See Door Types Operation/Handing: See Door Types

Marvin Ultimate Inswing Wood French Door (UWIFD)

East Garage Elevation

Scale: 1/4"=1'-0"

South Garage Elevation

Scale: 1/4"=1'-0"

North Garage Elevation


Scale: 1/4"=1'-0"

West Garage Elevation

Scale: 1/4"-11 O"

South Garage Elevation

Scale: 1/4"=1'-0"

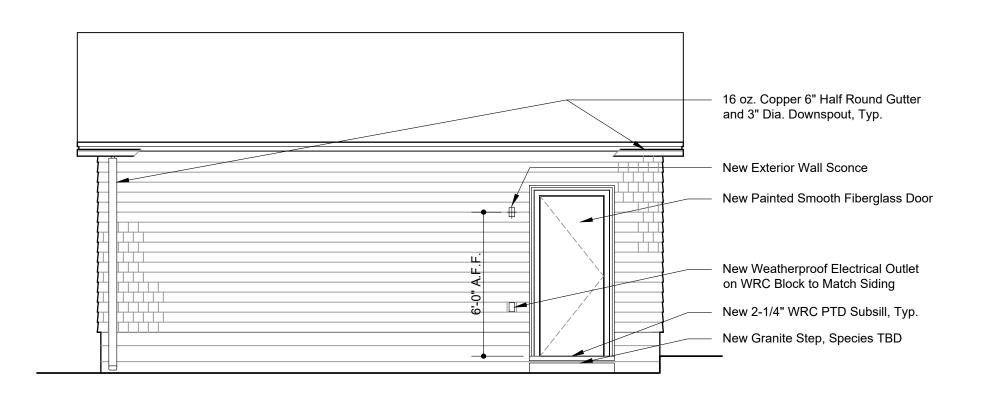




New Decorative Chip Epoxy Floor Coating, Color TBD

Existing CMU Stem Wall

New Granite Step, Species TBD

New Ptd V-groove Fiberglass Door

(G01)

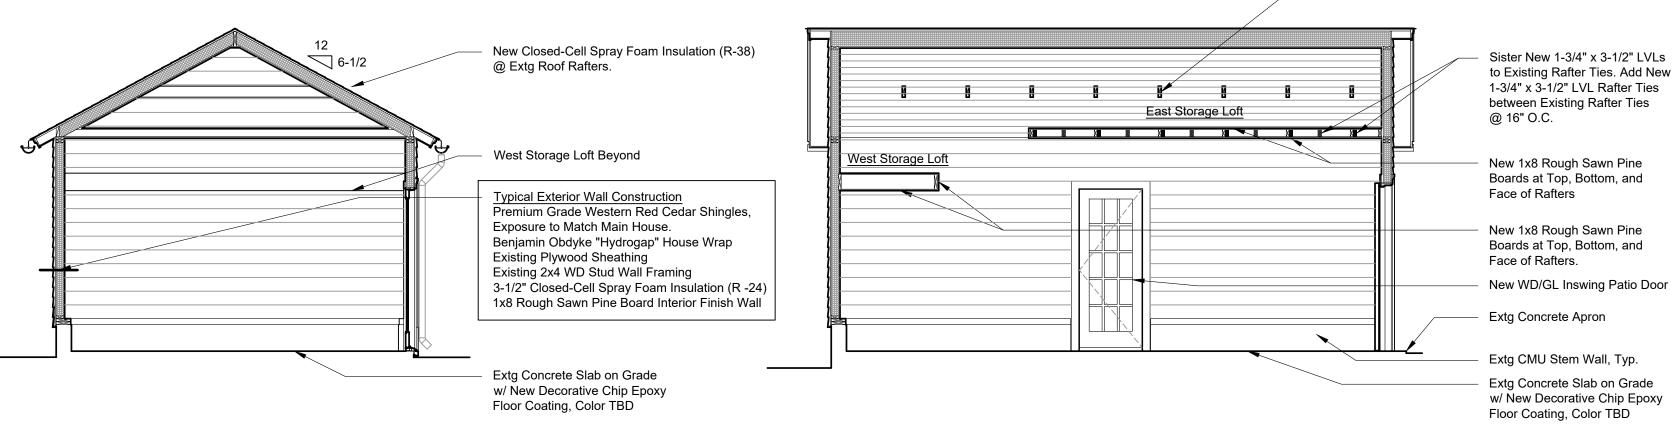

Line of Roof Above

Walls and Roof

and Ceiling Finish

Existing Concrete Apron

w/ Custom Stop


New Granite Step, Species TBD

New Closed Cell Spray Foam Insulation at

New 1x8 Rough Sawn Pine Board Interior Wall

New Marvin UWIFD2868 Inswing French Door

New 12' x 7' Raynor "Aspen AP200" Overhead Door

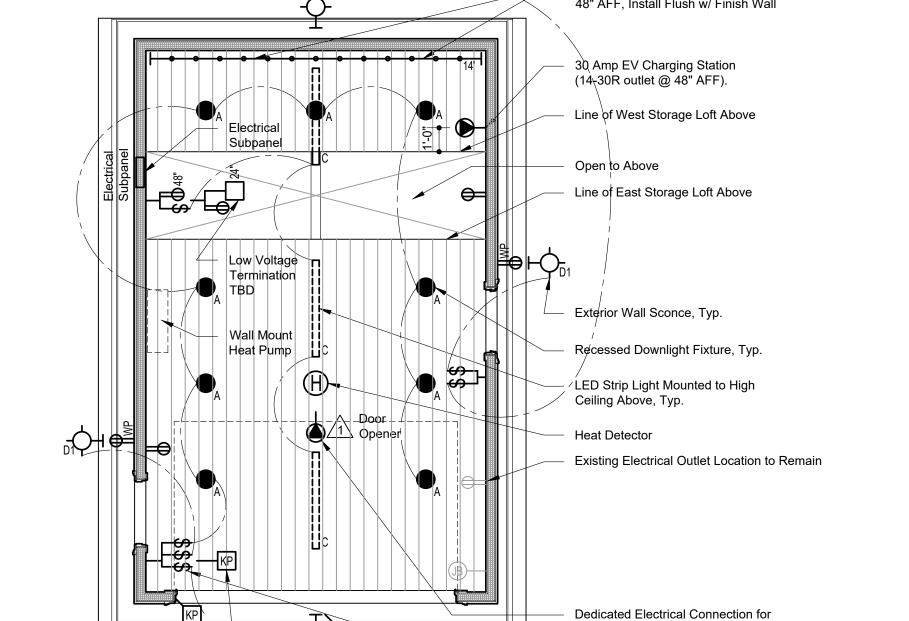

Revised for HDC Review and Approval

Issued for Cost Estimating 1/22/2021

## Floyd Gibbons Nordin Residence

36 Cherry Street Somerville, Massachusetts 02144-3204

Proposed Garage Plans, Elevations, and Sections

**Drawing Number** 17 January 2021

Scale 1/4" = 1'-0" Project No.

Drawing Title

G1-1 190202

MERRIMACK DESIGN

Architects 85 North Main Street White River Junction, VT 05001 telephone: 802-281-6478

URL: www. merrimackdesign.com © MERRIMACK DESIGN Architects

e-mail: info@merrimackdesign.com

Remove Existing Roof Eaves and Rake Trim, Typ. Remove Existing Floor Drain. Patch and Fill. Remove Existing Strip Light and Wiring <u>Garage</u> **Existing Concrete** Slab On Grade Remove Existing CMU Stem Wall, This Area for New Door Rough Opening Existing CMU Stem Wall Remove Existing Casement Window. New Door Opening to Align with Existing CMU Coursing. Remove Existing CMU Stem Wall, This Area, for New Door Rough Opening Remove Existing Siding, Typ. New Door Opening To Align With Existing CMU Coursing Remove Existing Garage Door, Frame and Track Hardware Remove Existing Switch and Outlet <u>----</u> Remove Fiberglass Louver Vent Above Remove Existing Exterior Light Fixture



8 Proposed Floor Plan
Scale: 1/4"=1'-0"


D2 MB

Selective Demolition Floor Plan

Scale: 1/4"=1'-0"

9 Proposed Reflected Ceiling Plan
Scale: 1/4"=1'-0"


### 5" Half-round seamless gutter profile - 10" coil stock

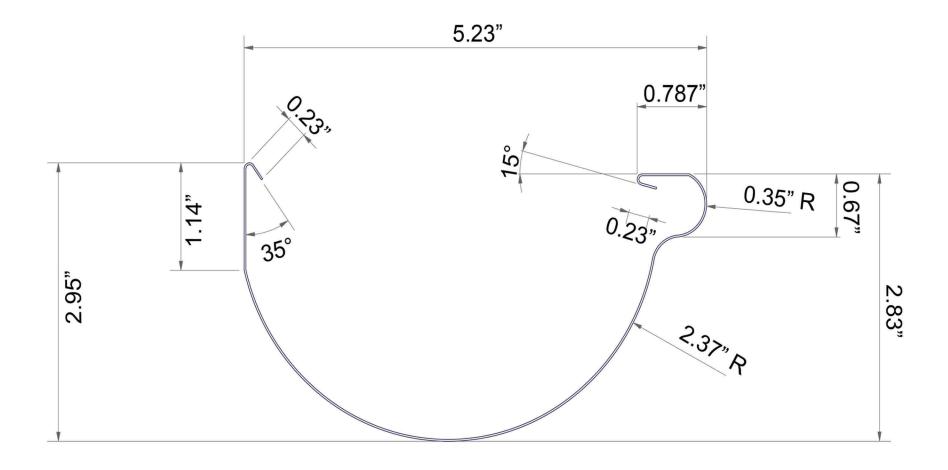



riversidesheetmetal.net

Approximate values

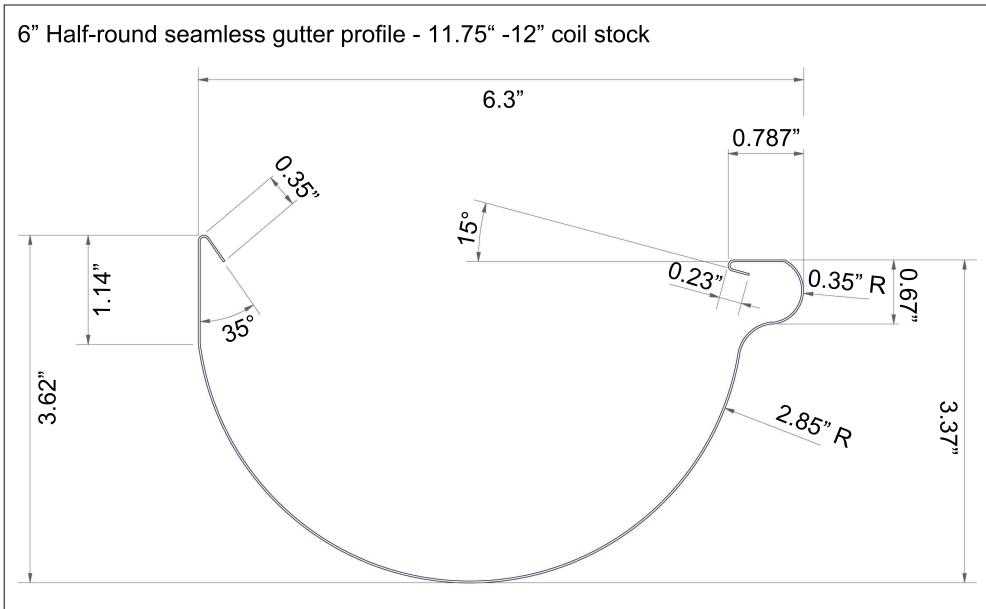



riversidesheetmetal.net

Approximate values

Light	Fixture Sche	dule															
Туре	Description	au.o	Manufact	turer	Name/Mo	idel No			Color/E	inich	Lar	mning	Din	encione	Remark	/e	
туре	Description	tion Manufacturer			Name/Model No.				Color/Finish		Lamping		Dimensions WxHxD		Remain		
Α	Recessed LED Elite			4" Round Regressed Slim LED RL455-550L-DIMTR-120-30K-90-BK			Black		9W LED			4" Dia. x -5/8"					
В	Motion Dete	Motion Detector RAB		3	GT500				Black		-		4" x	4" x 2-1/4" x 8"		120V, 60 Hz, Wet Location, Install w/ Light Fixture D2	
С	Linear LED	inear LED Fixture Saylite		te	Series 44 SS-44W-MW-48L-R24W2400L-G120 30K-90-BK			G120-	Black		24W LED		48" x 4" x 4"		Surface-mount		
D1	Exterior Wall Sconce Hi-Lit		te		ucer Vapor Jar Wall Light )-1B-91-CLRW/ D/INC			Black		Standard Incandescent Medium Base E26		10" Dia. x 10" x 11-1/2"		Wet-Rated			
D2	Exterior Wall Sconce Hi-Lite		te	Goosene	/arehouse Shade ck 'H-QSN15114-SA-91/ -91/ QSNWGR-14'-91/INC		Black		Standard Incandescent Medium Base E26		14" Dia. x 8-1/2" x 29-1/2"		Wet-Rated, 22" Gooseneck Arm, Surface-Mounted Junction Box				
				•					•								
Equip	ment Schedu	ıle															
Tag	Location	ation Description Manu			ufacturer Name/Model No.			Color/	Finish		mensions Power WxHxD Requireme		nt	Remarks			
1	Garage	Garage Door Opener		Ra	Raynor General II		neral II		NA		5" x 19" x 7.5" 2.7 Amp, 13		20V	Supply (2	upply (2) Remote Controls		
Gener	al Note: See	Electrical Pla	n for Equip	ment Lo	ocations.							•					
Door 9	Schedule																
Door No.	Mfr.	Model No.	Material/ Leaf Si Finish WxHxE			e Rough Opening WxH		Unit Size WxH		Hand			amb hickness	Hard ware Set	Remarks		
G01	Raynor	Aspen-20	0 Insulated Steel		144 x	44 x 84 x 2 Existi		ng	-		NA	Painted WRC		VIF	2	4 Flush panel overhead garagedoor w/ Door Opener, Color TBD, Custom Stop	
G02	Jeldwen	SP-100	) Fiberglass		32 x 80 x 1-3/4		37-1/2 x 83-1/4				RH	"Auralast"		4-1/2"	1	Prehung Exterior Door "Smooth Pro" SP-100, V-groove door panel	
G03	Marvin	UWIFD-2868 Douglas Fir. Temp GL					34-7/1 82-1/			6 x 82	RH	RH Painted WRC		4-9/16"	NA	15-Lite Panel, See Specifications on Sheet G1-1	
				_				_		_							
Hardw	are Schedul	е															
Hardw	are Set #1 Er	ntrance	104	0-03 <sup>-</sup>	1												
Hinges	3	1 Pair Bald	win #1035	<del>040,</del> <mark>4"</mark> >	د 4", <mark>Ball F</mark>	inial, Polis	hed Brass, I	Unlacqu	iered (US3	NL)							
Latchs	et	Baldwin <del>#5</del>	510P 010	Passa	ige Latch,	2-3/4" Bac	kset, Stand	ard Box	Strike, Pol	lished E	Brass, Unla	cquered (US	3NL)	5520-	031		
Knob		1 Pair Bald	win <mark>#5000</mark>	-040 2" I	Knob and I	Rose, Polis	shed Brass,	Unlacq	uered (US3	3NL)							
Stop	1 Ives WS447 Wall Stop, Polished Brass, Unlacquered (US3NL)																
Auxilia	ary Deadbolt	1 Baldwin #	¢8021-040,	2-3/8" E	Backset, T	urn Piece/	Cylinder, Po	lished E	Brass, Unla	cquere	d (US3NL)	, coordinate	keying	with all ex	terior doc	ors	
Hardw	are Set #2 O	verhead Doo	r														
Weath	erstrip	Pemko Q102 Foam Kerf-In Weatherstrip, Black															
Issu	ed for Co	st Estim	ating 1	/22/20	021										©	MERRIMACK DESIGN Architect	

Drawing Title Garage Schedules	Date         Project No.         Scale           1/22/2021         190202         N.T.S.			Drawing Number
Project Title Floyd Gibbons Nordin	MERRIMA Architects			
36 Cherry St Somerville, MA 02144	P.O. Box 1007 Exeter, New Hampshire 03833 telephone: 603-658-0658 e-mail: info@merrimackdesign.com			G1-1A

#### **Proposed Garage Door**



### Massachusetts Cultural Resource Information System

#### Scanned Record Cover Page

Inventory No: SMV.130

Historic Name: Mentzner, W. C. House

**Common Name:** 

Address: 36 Cherry St

City/Town: Somerville
Village/Neighborhood: Spring Hill
Local No: 1036, 123
Year Constructed: 1890

Architect(s):

Architectural Style(s): Colonial Revival; Shingle Style
Use(s): Single Family Dwelling House

Significance: Architecture

Area(s): SMV.AY: Somerville Multiple Resource Area

**Designation(s):** Local Historic District (03/11/1985); Nat'l Register MRA

(09/18/1989); Nat'l Register DOE (09/18/1989)

Building Materials(s): Wall: Wood; Wood Shingle; Stone, Uncut

Foundation: Stone, Uncut



The Massachusetts Historical Commission (MHC) has converted this paper record to digital format as part of ongoing projects to scan records of the Inventory of Historic Assets of the Commonwealth and National Register of Historic Places nominations for Massachusetts. Efforts are ongoing and not all inventory or National Register records related to this resource may be available in digital format at this time.

The MACRIS database and scanned files are highly dynamic; new information is added daily and both database records and related scanned files may be updated as new information is incorporated into MHC files. Users should note that there may be a considerable lag time between the receipt of new or updated records by MHC and the appearance of related information in MACRIS. Users should also note that not all source materials for the MACRIS database are made available as scanned images. Users may consult the records, files and maps available in MHC's public research area at its offices at the State Archives Building, 220 Morrissey Boulevard, Boston, open M-F, 9-5.

Users of this digital material acknowledge that they have read and understood the MACRIS Information and Disclaimer (http://mhc-macris.net/macrisdisclaimer.htm)

Data available via the MACRIS web interface, and associated scanned files are for information purposes only. THE ACT OF CHECKING THIS DATABASE AND ASSOCIATED SCANNED FILES DOES NOT SUBSTITUTE FOR COMPLIANCE WITH APPLICABLE LOCAL, STATE OR FEDERAL LAWS AND REGULATIONS. IF YOU ARE REPRESENTING A DEVELOPER AND/OR A PROPOSED PROJECT THAT WILL REQUIRE A PERMIT, LICENSE OR FUNDING FROM ANY STATE OR FEDERAL AGENCY YOU MUST SUBMIT A PROJECT NOTIFICATION FORM TO MHC FOR MHC'S REVIEW AND COMMENT. You can obtain a copy of a PNF through the MHC web site (www.sec.state.ma.us/mhc) under the subject heading "MHC Forms."

Commonwealth of Massachusetts
Massachusetts Historical Commission
220 Morrissey Boulevard, Boston, Massachusetts 02125
www.sec.state.ma.us/mhc

This file was accessed on: Monday, September 13, 2021 at 6:09: PM

ORM B - BUILDING

NRMRA/DOE 9/18/89 (10,1NC)

ASSACHUSETTS HISTORICAL COMMISSION 0 BOYLSTON STREET COSTON, MA 02116 WHCH



ketch Map: Draw map showing property's location n relation to nearest cross streets and/or eographical features. Indicate all buildings etween inventoried property and nearest ntersection(s).

See Attached Assessor's Map

JTM REFERENCE	Z 19	07.5 52.1 50.6	E 326/760	N - 4695/120
JSGS QUADRANGLE	ie i a	В	ston Nor	rth
SCALE	1:	25	5,000	

	OFFICE COPY DO NOT REMOVE LHD-3/11/85 2e AREA FORM NO.
J.P.	AY Spring 128 130  PI-SPRING- USGS-BOST,N
_	Somerville SEC+B
	36 Cherry Street
	ic Name W. C. Mentzner House
7	Present residential
	original residential
	PTION
	1890
$\dashv$	Somerville Past and Present
	Queen Anne/Shingle Style
VICIT	Lect unknown
	ior Wall Fabric <u>shingle with fieldstone</u> foundation & trim ildings <u>garage</u>
Major	Alterations (with dates)
Condi	class conservatory was sided - 20th century tionGood
ples o field	t the Shingle-Duess Stone this and res
Moved	No Date N/A
Acrea	ge less than one acre
	ng West side of Cherry St., in a
	ential setting of late 19th & early
	century dwellings, many undergoing
1-100	sive change. Near Summer Street.
c Que	they built on the
	ded by Betsy Friedberg, Preservation Planner
	ization Mass. Historical Commission
Date	June 1986

NATIONAL REGISTER CRITERIA STATEMENT (if applicable)
The Mentzner House, a Queen Anne/Shingle Style residence
representative of the stylish businessmen's dwellings built on the
hills above Union Square in the late 19th century, retains integrity
of location, design, materials, and association and fulfills
Criterion A and C of the National Register of Historic Places on the
local level.

ARCHITECTURAL SIGNIFICANCE Describe important architectural features and evaluate in terms of other buildings within the community.

The Mentzner House is one of the best examples of the Shingle-Queen Anne style in Somerville: of note are the fieldstone trim and rear octagonal tower. The building's gambrel roof incorporates a full-width front porch with Ionic columns.

HISTORICAL SIGNIFICANCE Explain the role owners played in local or state history and how the building relates to the development of the community.

Cherry Street between Elm and Summer Street was a popular location for businessmen's architecturally distinctive houses during the second half of the 19th century. 36 Cherry Street was built by Walter Mentzner, who moved to Somerville in 1872. With his brother Albert, he ran a whole provision business (W. C. and A. F. Mentzer) Somerville. He was director of the Somerville National Bank, and vice president of the Somerville Cooperative Bank.

BIBLIOGRAPHY and/or REFERENCES

Samuels, Somerville Past and Present p. 593.

DO NOT REMOVE

